

REWARD CHARACTER **DESIGNS**

BUILDING DESIGN & CREATOR

PROPOSED LOT CONSOLIDATION AND NEW SUBDIVISION

9, 11, 13 ROBERT ST, JUNEE, NSW, 2663

LOT B DP 36152 LOT SIZE - 1911.64m² LGA: JUNEE SHIRE COUNCIL LOT C DP 36152 LOT SIZE - 1273.92m² LGA: JUNEE SHIRE COUNCIL LOT 24 DP 36150 LOT SIZE - 965.76m² LGA: JUNEE SHIRE COUNCIL

DESIGNED FOR:

CHRIS BLANCHARD

DRAWING SCHEDULE:

TITLE

EXISTING SITE PLAN

PROPOSED SITE PLAN / SERVICES PLAN A02

REVISION:

PRELIMINARY. 1 13/09/2023 PRELIMINARY. 2 2/11/2023 FINALS DRAFT. 14/12/2023 FINALS. 18/12/2023 AMENDED FINALS. 11/01/2024 AMENDED FINALS. 16/01/2024

DESIGNED: REWARD CHARACTER DESIGNS

0406 140 093

REWARDCHARACTERDESIGNS@HOTMAIL.COM

EXISTING SERVICES

POWER SEWER W WATER

BUILDING NOTES

ALL: CONSTRUCTION WORKS ARE TO COMPLY WITH THE NATIONAL CONSTRUCTION CODE OF AUSTRALIA AND ANY RELEVANT AUSTRALIAN STANDARDS OR LOCAL COUNCIL AUTHORITY REQUIREMENTS REFERENCED IN THE PLANS.

BUILDING DESIGN PLANS: ARE TO BE READ IN CONJUNCTION WITH THE SPECIFICATIONS AND PROFESSIONAL ENGINEERING PLANS / MANUFACTURERS PLANS

BUILDER / CONTRACTORS: TO CONFIRM LEVELS AND DIMENSIONS AND ANY OTHER DETAILS ON SITE PRIOR TO THE COMMENCMENT OF WORKS.

BUILDER: TO ENSURE UNDERGROUND SERVICES, PIPES AND CABLES TO BE LOCATED PRIOR TO EXCAVATION WORKS. CALL DIAL BEFORE YOU DIG ON 1100 OR GO TO WWW.1100.COM.AU.

SITE MANAGEMNET: TO COMPLY WITH THE LOCAL COUNCIL AUTHORITY FOR THE SUPPLY/ INSTALL AND MAINTENANCE OF THE FOLLOWING:

- SEDIMENT CONTROL MEASURES
- -STABILISED ENTRY POINT
- -CONTROLLED RUBBISH AREA
- -TOILET FACILITIES

BASIX: SELECTIONS TO COMPLY WITH ENERGY EFFICIENCY PERFORMANCE REQUIREMENTS OF THE ASSOCIATED BASIX CERTIFICATE.

CONCRETE: SLABS AND FOOTINGS ARE TO BE TO ENGINEERS SPECIFICATIONS AND

COMPLY WITH AS 2870 RESIDENTIAL SLABS AND FOOTINGS

STORMWATER/ SEWER: MUST BE DESIGNIGED AND INSTALLED TO COMPLY WITH AS/NZS 3500.3 - 2003 (PLUMBING AND DRAINAGE - STORMWATER DRAINAGE) OR AS/NZS 3500.5 -2000(NATIONAL PLUMBING AND DRAINAGE DOMESTIC INSTALLATIONS)

TERMITE PROTECTION TERMITE PROTECTION: PROVIDE PHYSICAL AND CHEMICAL

TERMITE BARRIERS IN ACCORDANCE WITH NCC 22 VOL HOUSING PROVISIONS, PART 3.4 TERMITE RISK MANAGEMENT AND AS 3660.1.

MASONRY: TO BE IN ACCORDANCE WITH AS 3700 (MASONRY STRUCTURES).

ELECTRICAL: DESIGN AND INSTALLATION TO COMPLY WITH AS/NZS 3018 -2001

(ELECTRICAL INSTALLATIONS - DOMESTIC INSTALLATIONS)

INTERNAL WET AREA WATERPROOFING: TO COMPLY WITH AS 3740 - 2010 WATER PROOFING OF DOMESTIC WET AREAS & NCC 22 VOL. HOUSING PROVISIONS PART 10.2 WET AREA WATER PROOFING

EXTERNAL WET AREA WATERPROOFING: TO BE IN ACCORDANCE WITH NCC 22 VOL 2 PART H2D8 EXTERNAL WATERPROOFING AND MATERIALS SELECTION, SYSTEM DESIGN AS PER


GLAZING: SELECTION AND INSTALLATION TO AS 2047 AND GLASS TYPE AND THICKNESS TO AS 1288. ALL OTHER COMPONENTS TO COMPLY WITH RELATIVE STANDARDS.

TIMBER: STRUCTURAL TIMBER TO COMPLY WITH AS 1684 & TO ENGINEERS DETAILS. DECORATIVE TIMBER FEATURES TO BE AS SELECTED.

STEEL: REFER TO BUILDING SPECIFICATIONS & ENGINEERS DETAILS.

HAZARDS: ALL CARE IS TO BE TAKEN BY ONSITE CONSTRUCTION WORKERS. RELEVANT QUALIFICATIONS/ INSURANCES / INDUCTIONS ARE TO BE UP TO DATE PRIOR TO COMMENEMENT OF WORKS. HAZARDS INCLUDE BUT ARE NOT LIMITED TO THE

- CHEMICALS- E.G PAINTS, SOLVENTS & SEALANTS.
- CONSTRUCTION MATERIALS- E.G TREATED TIMBER, ASBESTOS REMOVAL, INSULATION.
- -WORKING AT HEIGHTS.
- -WORKING IN CONFINED SPACES.
- -DEMOLITION WORKS.

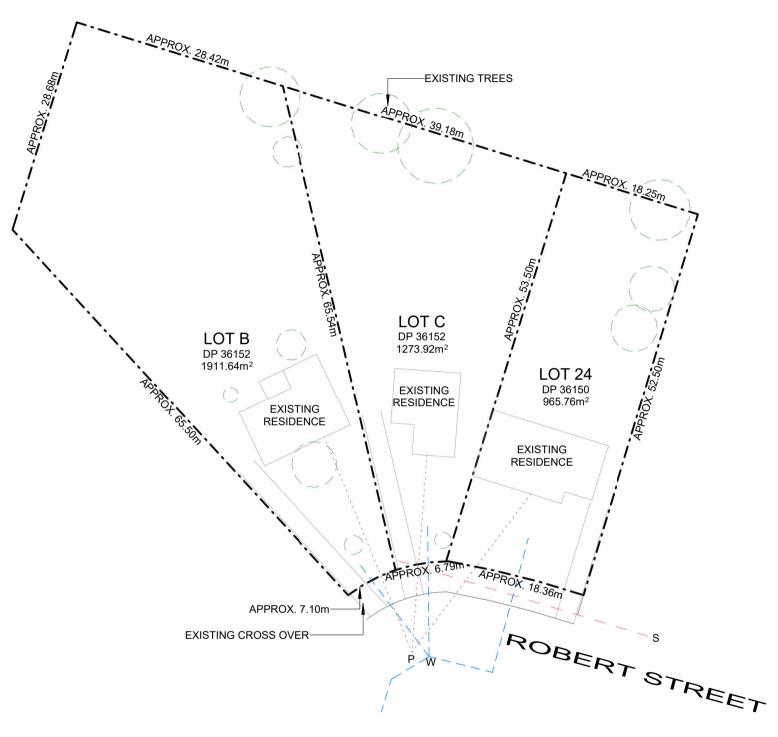



EXISTING SITE PLAN

SCALE AT A3 1:500



28RCD23

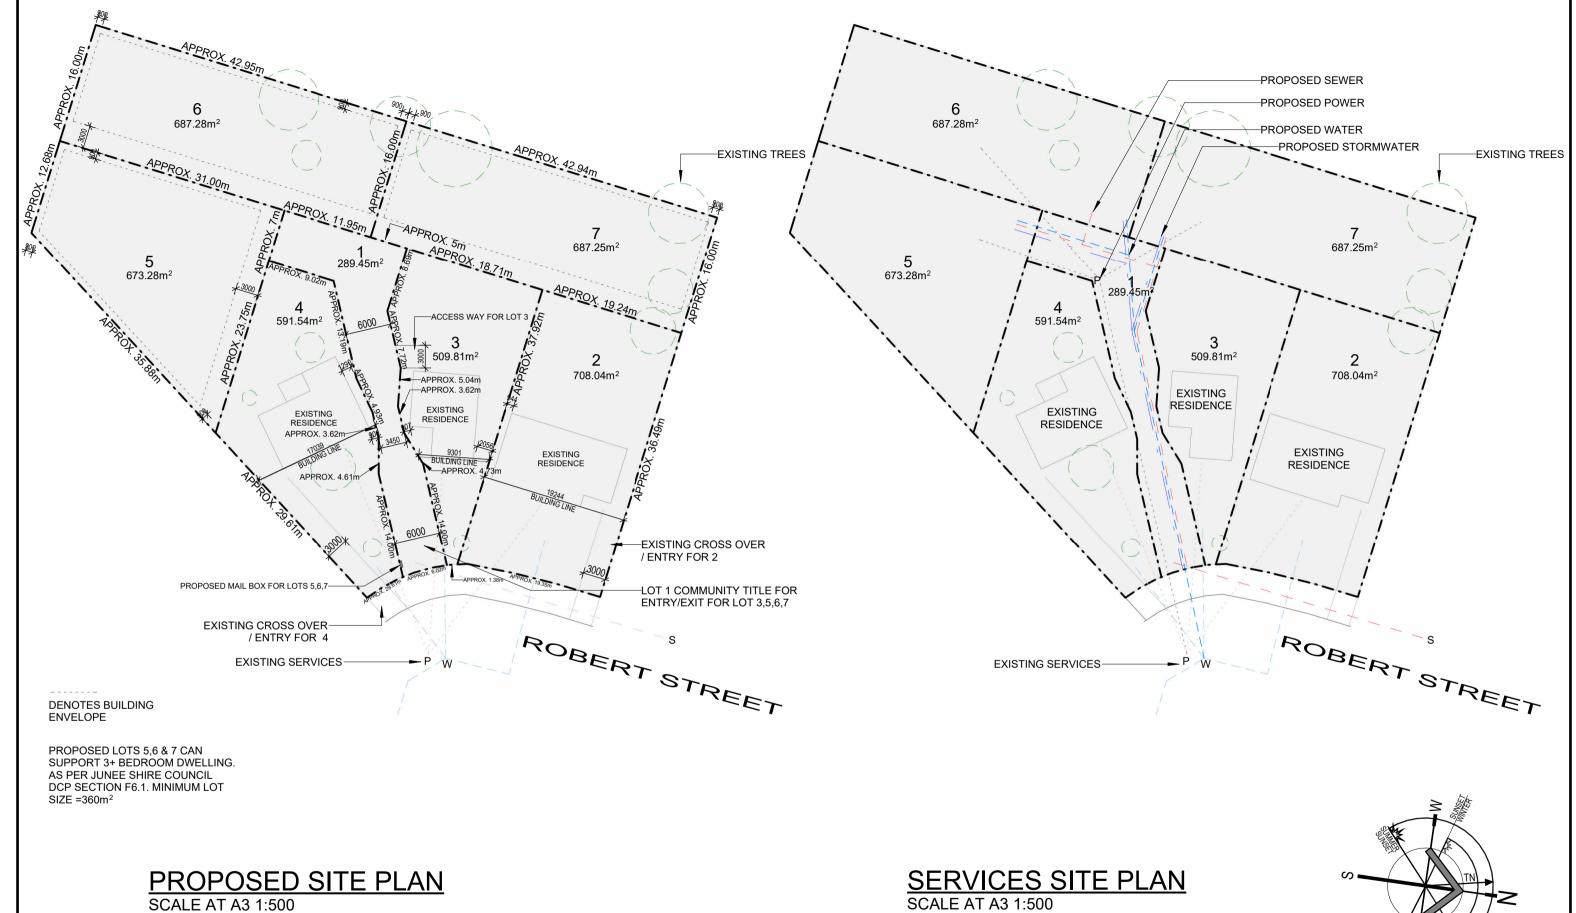

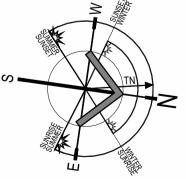



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DRAWING TITLE SITE PLANS **CHRIS BLANCHARD** DATE // TIME 16/01/2024 4:08:14 PM

SCALE AS SHOWN STATUS **AMENDED FINALS** PROJECT ID 28RCD23

DRAWN BY
GUY WARD BUILD BY TBC